






EVISED 2018 IRC


Sheet


Job #:


OF 6

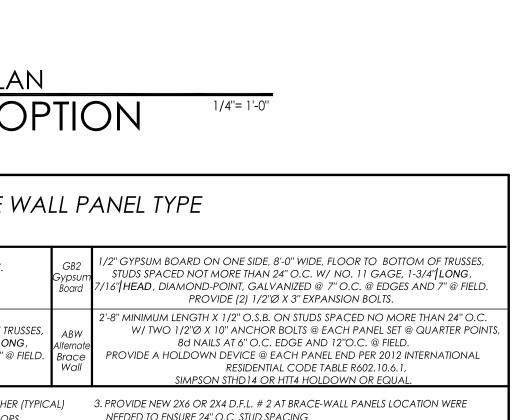



1/4"= 1'-0"

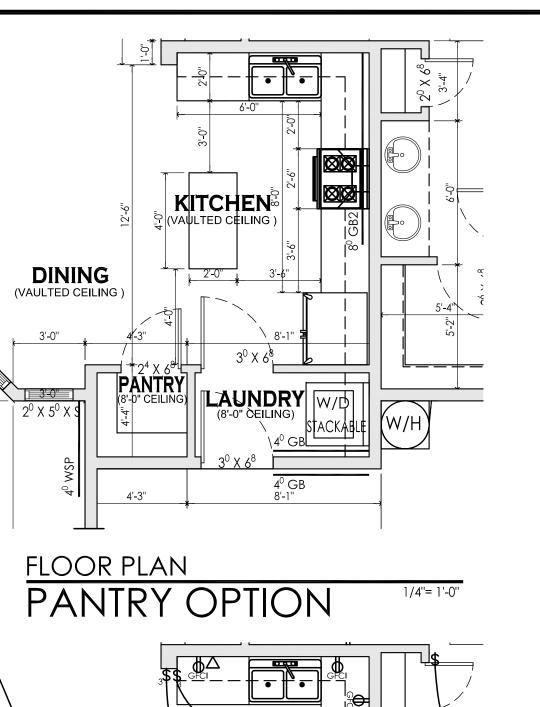

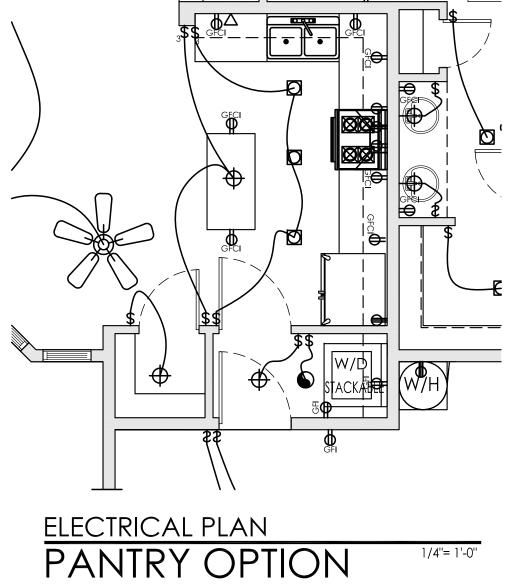

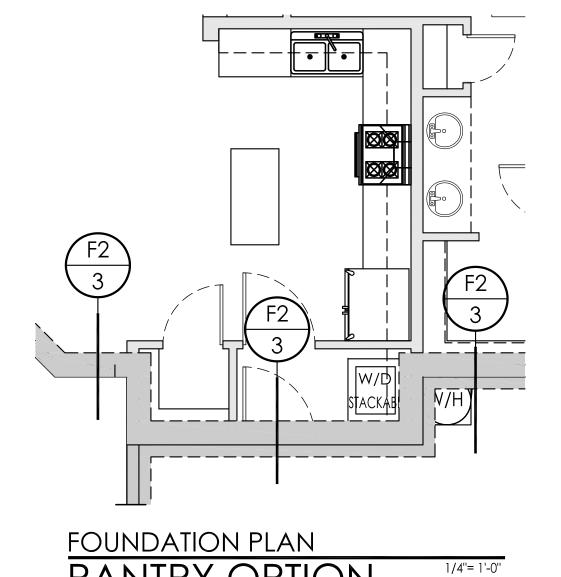

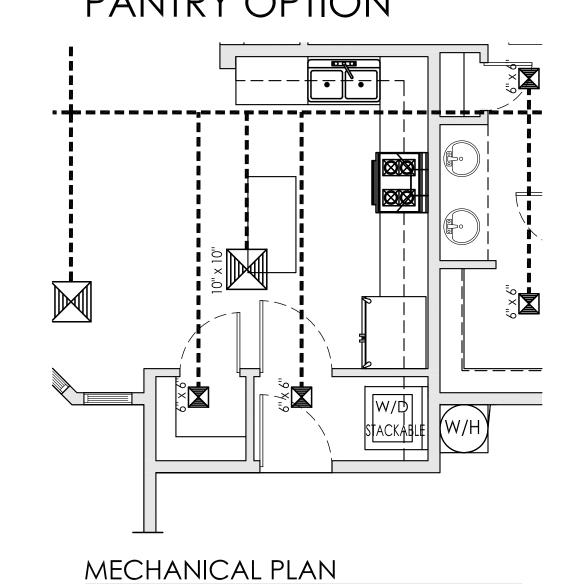

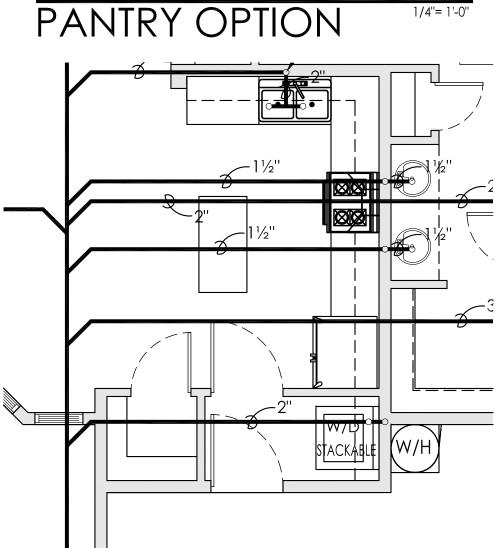

PLUMBING PLAN PANTRY OPTION

1/4"= 1'-0"

14'-7''

4⁰ X 4⁰ X 0

BEDROOM 2
(8'-0" CEILING)

6⁰ X 6⁸ SD

BEDROOM 2

9'-10"

FLOOR PLAN

4⁰ WSP

PATIO (8'-0" CEILING)

6⁰ X 6⁸ SGD

LIVING

 4^0 WSP

DINING (VAULTED CEILING)

2⁰ X 5⁰ X 0

 2^8 ABW

PORTICO (9'-0" CEILING)

3'-0''

4'-2"

KITCHEN (VAULTED CEILING)

4⁰ GB

GARAGE (8'-0" CEILING)

16⁰ X 7⁰ GARAGE DOOR

21'-4"

5⁰ X 4⁰ X 0

M. BEDROOM
(8'-0" CEILING)

3⁰ X 6⁸ BARN DOOR

GARAGE DOOR OPTIONAL

2⁸ ABW

2'-8"

M. BATH
(8'-0" CEILING)

AREAS:

LIVABLE AREA: ====== 1282 SF. GARAGE :======= 485 SF. 127 SF. PORTICO: ====== 96 SF PATIO : =======


GENERAL NOTES


- 1 ALL INTERIOR DOORS SHALL BE 6'-8" HEIGHT (U.N.O.)
- 2 ALL SHOWER AND TUB AREAS SHALL BE FINISHED WITH A SMOOTH, NON-ABSORBENT SURFACE TO A HEIGHT OF NOT LESS THAN 70" ABOVE THE DRAIN INLET.
- 3 PROVIDE 1/2" GYPSUM BOARD ON GARAGE SIDE OF WALL SEPARATING DWELLING AND GARAGE - GYP. BD. SHALL EXTEND UP TO BOTTOM OF ROOF DECK.
- 4 RANGE TO BE VENTED TYPICAL
- 5 PROVIDE 22" X 30" ATTIC ACCESS PANEL IN DWELLING AREA
- 6 ALL DEADBOLTS AT EGRESS DOOR SHALL BE OPENABLE FROM INSIDE WITHOUT THE USE OF A KEY.
- 7 PENETRATIONS AT GARAGE TO HOUSE (OTHER THAN 26 GA DUCTS) SHALL BE SEALED WITH APPROVED MATERIALS TO RESIST THE FREE PASSAGE OF FLAMES AND PRODUCTS OF COMBUSTION, MEETING ASTM 136 CRITERIA,
- 8 USABLE SPACE BENEATH STAIRS TO HAVE $\frac{1}{2}$ " GYPSUM BOARD MINIMUM.
- 9 SITE ADDRESS, NUMBERS TO BE MINIMUM 4" HIGH X $\frac{1}{2}$ " STROKE, AND NUMBERS TO CONTRAST WITH THEIR BACKGROUND.


BRACE WALL PANEL DESIGNATION	BRACE WALL PANEL TYPE		
WSP Wood Structural Panel	1/2" O.S.B. ONE SIDE, 4'-0" WIDE ON STUDS SPACED @ 24" MAX. O. C. 6d COMMON NAILS @ 6" O.C. @ EDGES AND 12" O.C. @ FIELD. PROVIDE 1/2"Ø X 10" A.B. @ 48" O.C.	GB2 Gypsum Board	1/2" GYPSUM BOARD ON ONE SIDE, 8'-0" WIDE, FLOOR TO BOTTOM OF TRUSSES, STUDS SPACED NOT MORE THAN 24" O.C. W/ NO. 11 GAGE, 1-3/4" LONG , 7/16" HEAD, DIAMOND-POINT, GALVANIZED @ 7" O.C. @ EDGES AND 7" @ FIELD. PROVIDE (2) 1/2"Ø X 3" EXPANSION BOLTS.
GB Gypsum Board	1/2" GYPSUM BOARD ON EACH SIDE, 4'-0" WIDE, FLOOR TO BOTTOM OF TRUSSES, STUDS SPACED NOT MORE THAN 24" O.C. W/ NO. 11 GAGE, 1-3/4" LONG, 7/16" HEAD, DIAMOND-POINT, GALVANIZED @ 7" O.C. @ EDGES AND 7" @ FIELD. PROVIDE (2) 1/2"Ø X 3" EXPANSION BOLTS.	ABW Alternate Brace Wall	2'-8" MINIMUM LENGTH X 1/2" O.S.B. ON STUDS SPACED NO MORE THAN 24" O.C. W/ TWO 1/2"Ø X 10" ANCHOR BOLTS @ EACH PANEL SET @ QUARTER POINTS 8d NAILS AT 6" O.C. EDGE AND 12"O.C. @ FIELD. PROVIDE A HOLDOWN DEVICE @ EACH PANEL END PER 2012 INTERNATIONAL RESIDENTIAL CODE TABLE R602.10.6.1, SIMPSON STHD14 OR HTT4 HOLDOWN OR EQUAL.
Gypsum Board NOTES: 1. ALL A	7/16" HEAD, DIAMOND-POINT, GALVANIZED @ 7" O.C. @ EDGES AND 7" @ FIELD. PROVIDE (2) 1/2"Ø X 3" EXPANSION BOLTS.	Alternate Brace Wall	PROVIDE A HOLDOWN DEVICE @ EACH PANEL END PER 2012 INT RESIDENTIAL CODE TABLE R602.10.6.1,

Scale: Date:AUGUST 201
Drawn: Job #:
Design:
Sheet

heet $2_{\sf OF\,6}$

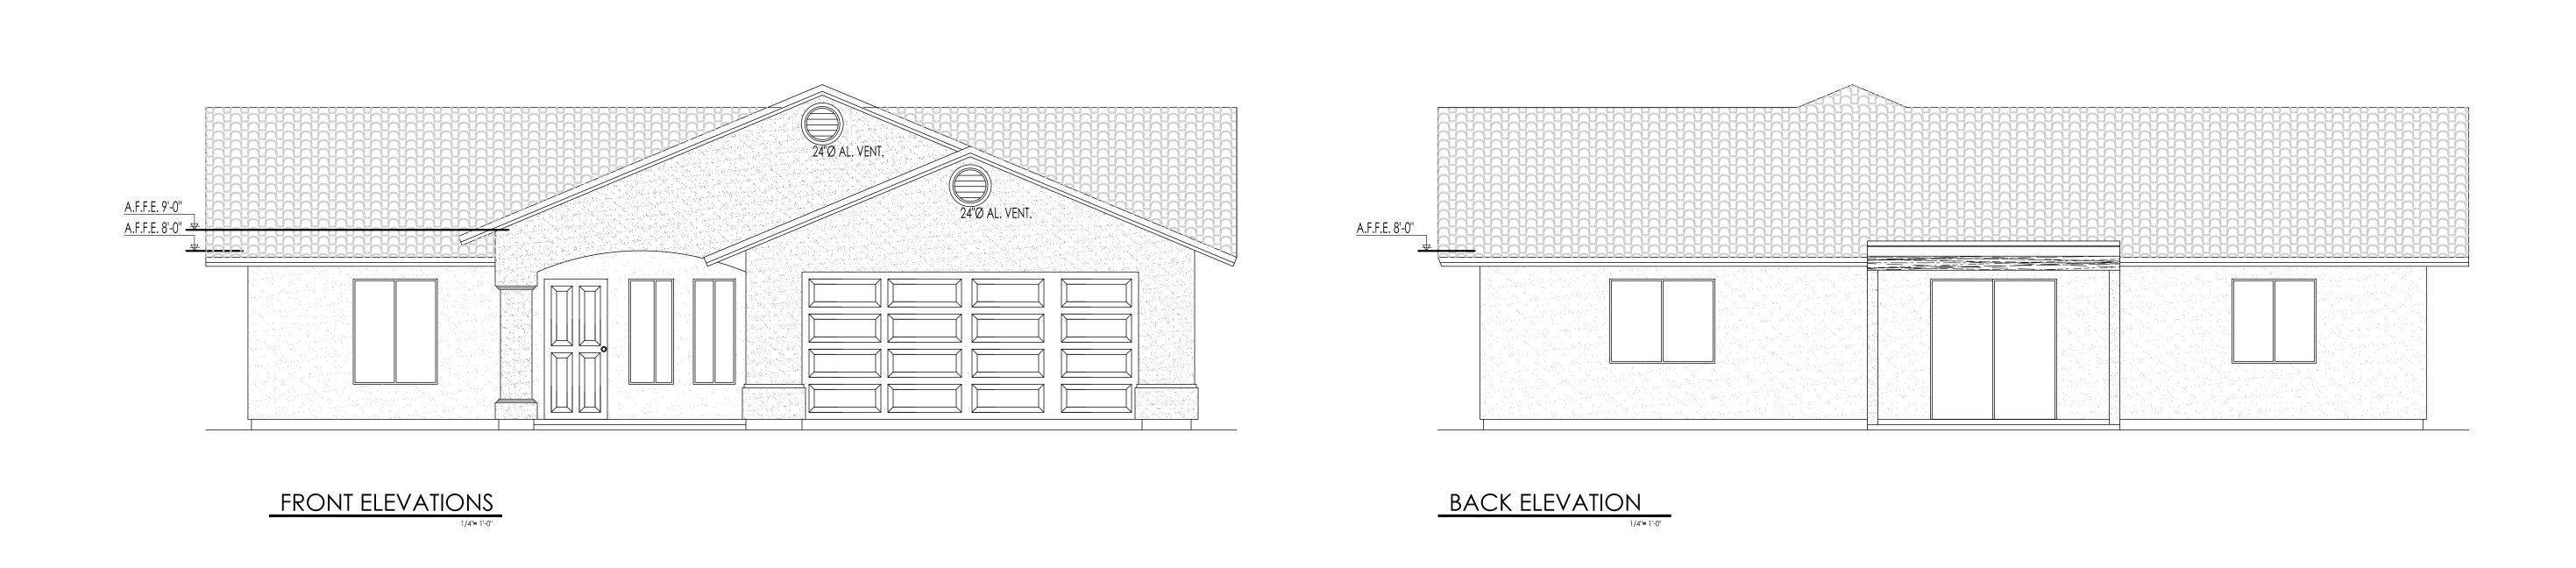

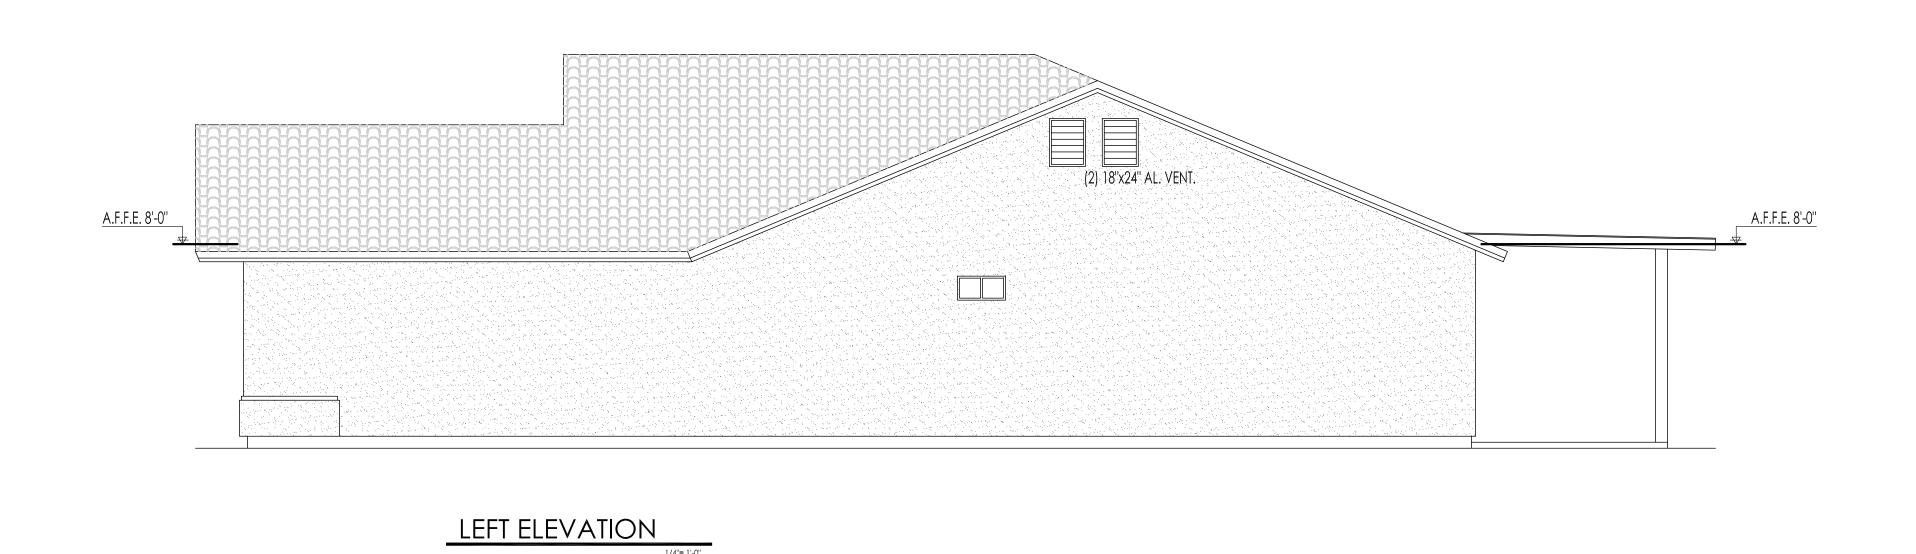

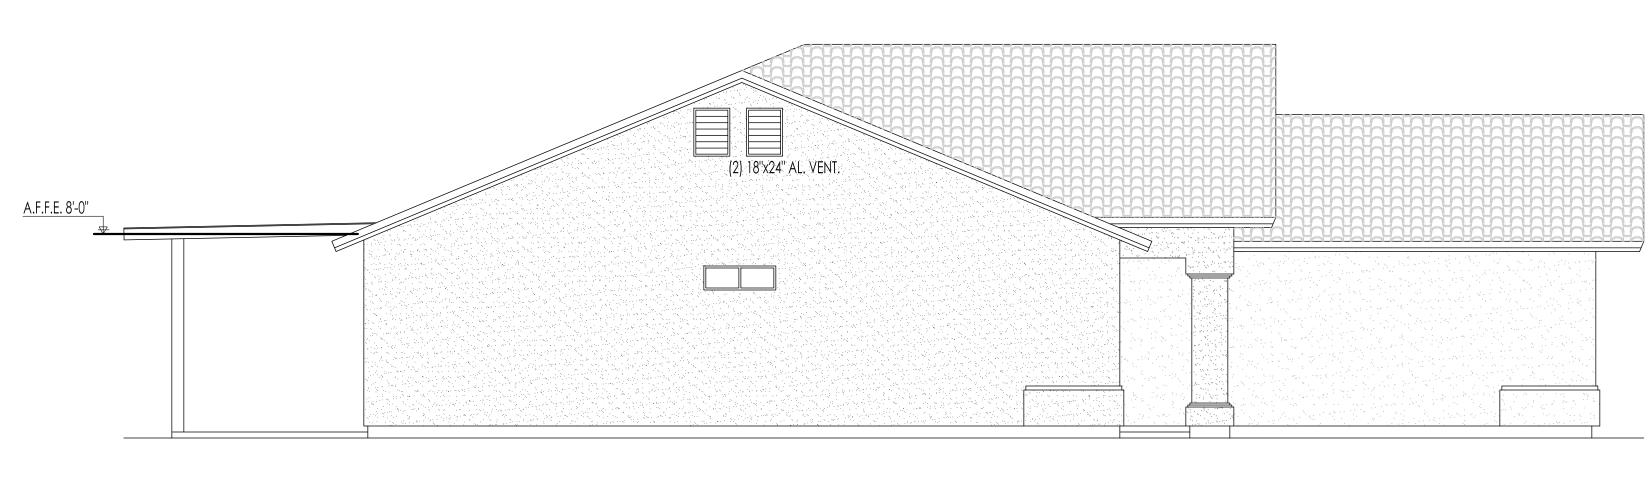

RIGHT ELEVATION